PLAN 2

PLANNING APPLICATION PLN-20-0176

96-102 FAIRTLOUGH STREET (APPROVED LOT 30, WILL BE 102 FAIRTLOUGH STREET), PERTH

ATTACHMENTS

- A Application & plans, correspondence with applicant
- B Responses from referral agencies
- C Representations

1-413 PLANNING APPLICATION

Proposal



Description of proposal:New7-bedroom dwelling with deck & landings
(attach additional sheets if necessary)
If applying for a subdivision which creates a new road, please supply three proposed names for the road, in order of preference:
1 3 3
Site address: Lot 30, Diamond Park Estate, Perth 7300
CT no:TBC
Estimated cost of project \$.476,113.00 (include cost of landscaping, car parks etc for commercial/industrial uses)
Are there any existing buildings on this property? Yes / No If yes – main building is used as
If variation to Planning Scheme provisions requested, justification to be provided:
(attach additional sheets if necessary)
(attach additional sheets if necessary) Is any signage required?





FOLIO PLAN

RECORDER OF TITLES 14



Issued Pursuant to the Land Titles Act 1980

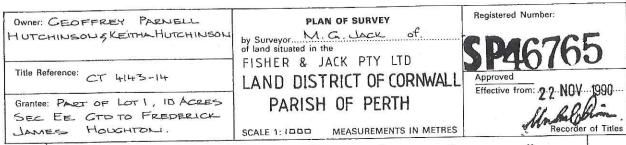

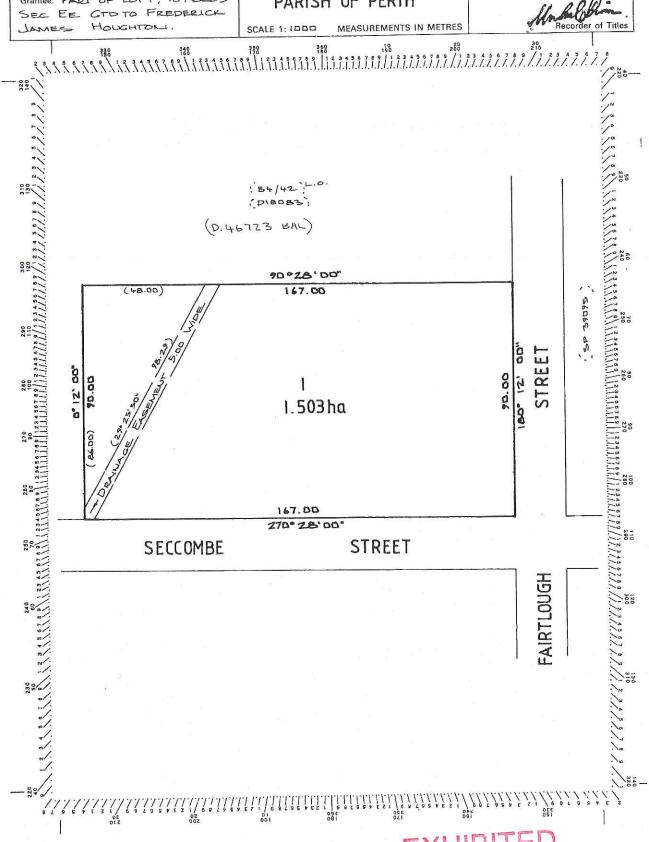

EXHIBITED

EXHIBITED

AMENDED

ISSUED FOR REVIEW

Client: SAAT Copyright (c)

Mob DA17 362 783 or 0417 545 813 ENGINEERING Address: LOT 30 OF 84, 94, 96-102 Project: PROPOSED DWELLING FAIRTLOUGH STREET, PERTH Drawing No:

Date Drawn: 26.05.20 Address Checked: C. Parry
Approved: J. Pfelffer Jacked: C. Parry
Approved: J. Pfelffer J. Pfelffer Jacked: C. Parry
Approved: J. Pfelffer J. Pfelff

Rev


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A02

ISSUED FOR REVIEW RE-ISSUED FOR REVIEW

PILIUS PROJECT MANAGEMENT
PROJECT MANAGEMENT ENGINEERING Tasbuilt Manufactured Homes & Cabirs P.O Box 274, Deloraine Tasmania 7304 Ph; 03 6393 1013 tasbuilthomes



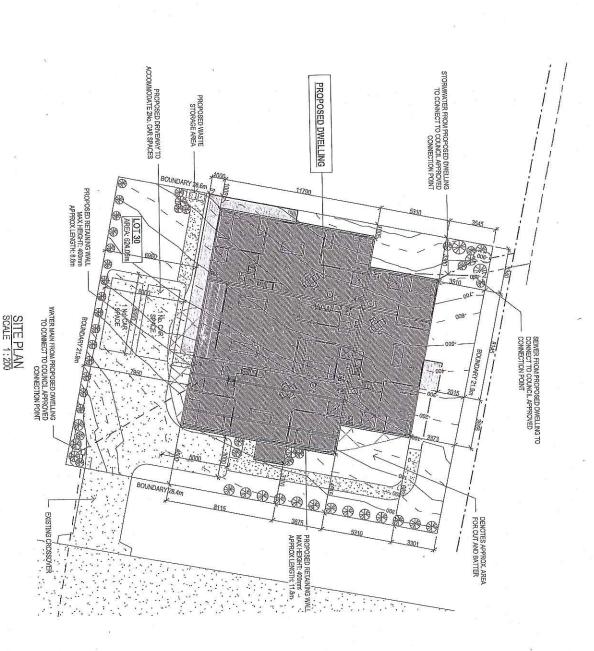

ISSUED FOR REVIEW RE-ISSUED FOR REVIEW Approved: J. Pfeiffer Jackson

Scale: As Shown @ A3 Infection

24.09.20 O.J Accredited Building Designer

29.05.20 O.J Designer Name: J.Pfeiffer

Darter Treft Accreditation No: CC2211T Date Drawn: 26.05.20
Drawn: O. Jones
Checked: C. Parry

ISSUED FOR REVIEW

IMPERVIOUS SURFACES 395.664m2

63,40%

DX-NBITED

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Client:

Address: LOT 30 OF 84, 94, 96-102 Project: PROPOSED DWELLING SAAT FAIRTLOUGH STREET, PERTH

Mob 0417 362 783 or 0417 545 813 ENGINEERING: jack@engineeringplus.com.au PI/US COMMENT.


Drawing No: 712020

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CIVIL/STRUCTURAL ENGINEERING



Tasbulit Manufactured Homes & Cabins P.O Box 274, Deloraine Tasmania 7304 Ph: 03 6393 1013 admin@rasbulithomes.com.au tasbuilthomes

Name DWELLING DECK LANDING LANDING LANDING

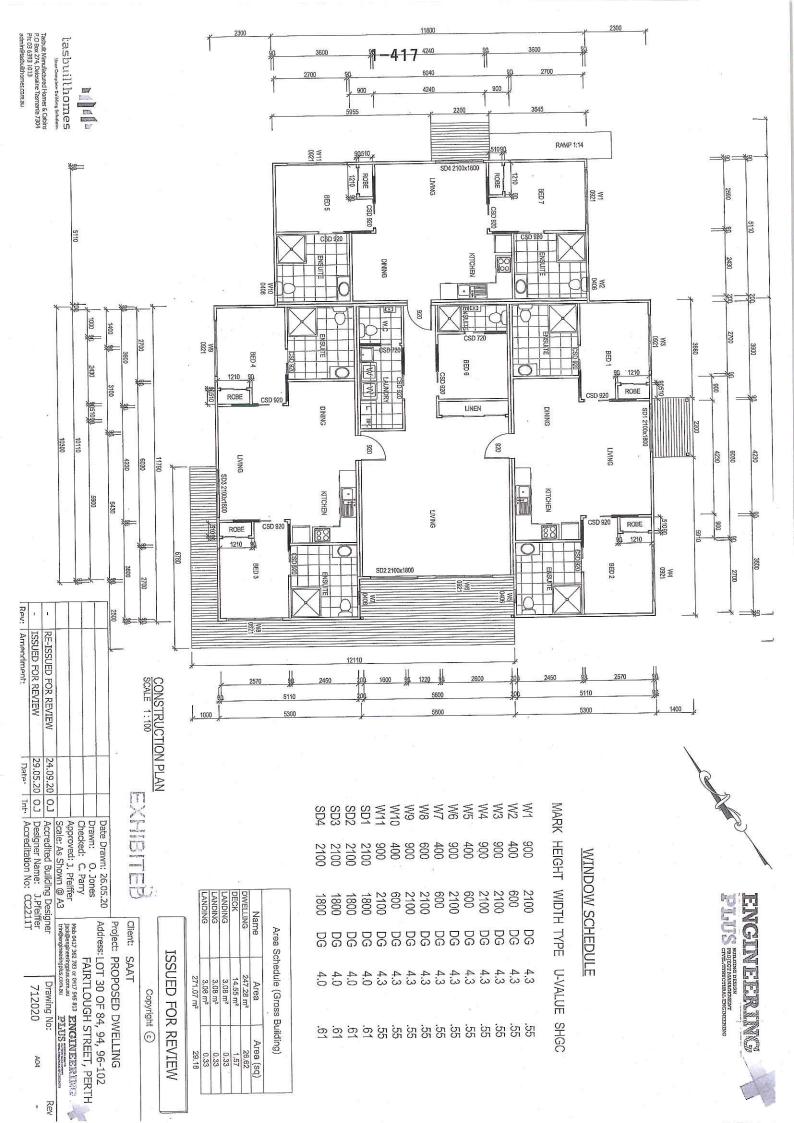
247.28 m² 14.55 m² 3.08 m² 3.08 m²

Area (sq)
26.62
1.57
0.33
0.33

271.07 m²

ISSUED FOR REVIEW RE-ISSUED FOR REVIEW Area Schedule (Gross Building)

Area

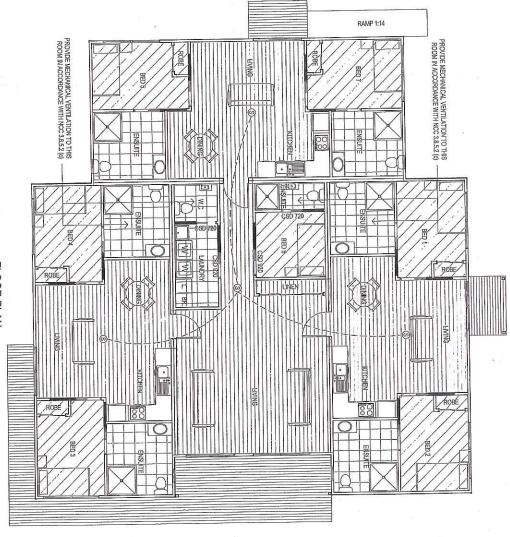

FLOOR PLAN SCALE 1:100

П

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Date Drawn: 26.05.20
Drawn: O. Jones
Checked: C. Parry

24.09.20 O.J Accredited Building Designer 29.05.20 O.J Designer Name: J.Pfeiffer Parte: Accreditation No: CC2211T Approved: J. Pfeiffer Scale: As Shown @ A3

Address: LOT 30 OF 84, 94, 96-102 Project: PROPOSED DWELLING

Client: SAAT

Mob 0417 362 783 or 0417 545 813 ENGINEER TUGG Jack@engineeringplus.com.au PIJUS CONTROLLER TUGG. Drawing No:

712020 A05

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FAIRTLOUGH STREET, PERTH

Rev

SMOKE ALARMS
PROVIDE AND INSTALL SMOKE ALARMS & HARD WIRE
TO BUILDING POWER SUPPLY TO AS 3786.
CEILING MOUNTED WITH 9VDC
ALKALINE BATTERY BACKUP
TO LOCATIONS INDICATED ON PLAN AND IN ACCORDANCE
WITH NCC PART 3.7.5.2

DENOTES INTERCONNECTED SMOKE DETECTORS

BUILDING DESIGN
PROJECT WANAGEMENT
COVIL/STRUCTURAL ENGINEERING ENGINEER

FLOOR COVERINGS

CARPET

TIMBER DECKING CONCRETE

ILE

VINYL TIMBER FLOORING

SUB FLOOR VENTILATION. BCA VOLUME 2 PART 3.4.1.

A MINIMUM OF 150 MM OF SUB FLOOR CLEARANCE IS TO BE PROVIDED BETWEEN FINISHED SURFACE LEVEL 8, THE UNDERSIDE OF THE FLOOR BEARER, A MINIMUM OF 6000 MM2 PER METRE OF SUB FLOOR VENTILATION IS TO BE UNIFORMLY DISTRIBUTED AROUND THE EXTERNAL AND INTERNAL WALLS OF THE BUILDING.

YENTS TO BE LOCATED NO GREATER THAN 600 MM FROM AN INTERNAL OR EXTERNAL CORNER.


ENDITOR DESIGN
BUILDING DESIGN
BUILDING DESIGN ENGINEER

PRYDA 230x165 - 117 HOLE VENT MAXIMUM SPACING 2350 MM ALONG WALL PRYDA 230X75 - 52 HOLE VENT MAXIMUM SPACING 1050 MM ALONG WALL OR

CONCRETE VERANDAH'S, DECKS, PATIOS AND PAVING ARE INSTALLED & OBSTRUCT VENTILATION. ADDITIONAL VENTILATION PROVISIONS TO BE INSTALLED WHERE OBSTRUCTIONS SUCH AS

HEIGHT SCYON AXON 133 CLADDING COLOUR: IRONSTONE FLOORLEVEL CEILING LEVEL TO NCC STANDARDS COLORBOND 'CUSTOM ORB' ROOFING COLOUR: WALLABY ALUMINIUM FRAMED SLIDING DOOR UNIT WITH TOUGHENED SAFETY GLASS ROUGH SAWN TAS OAK CLADDING COLDUR: OILED JARRAH TIMBER SUB FLOOR SLATS COLOUR: STAINED 1 SCYON AXON 133 CLADDING COLOUR: IRONSTONE PROPOSED RETAINING WALL MAX HEIGHT: 400mm ALUMINIUM WINDOW FRAMES COLOUR: PRECIOUS SILVER COLORBOND GUTTER AND FASCIA COLOUR: WALLABY

SOUTH ELEVATION SCALE 1:100

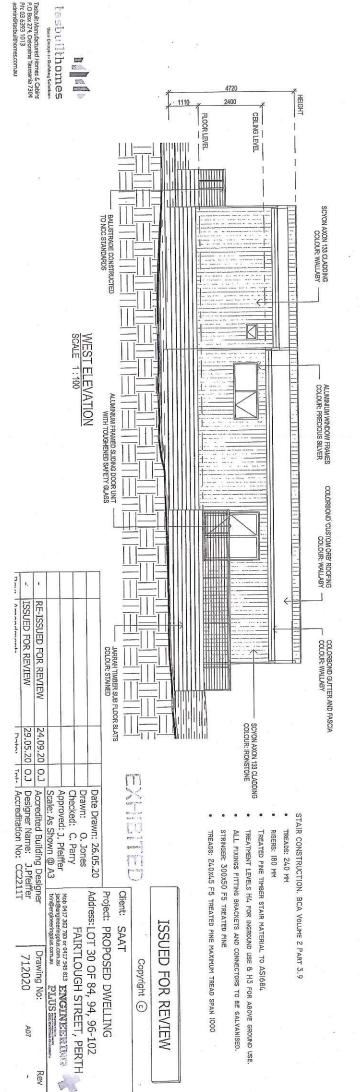


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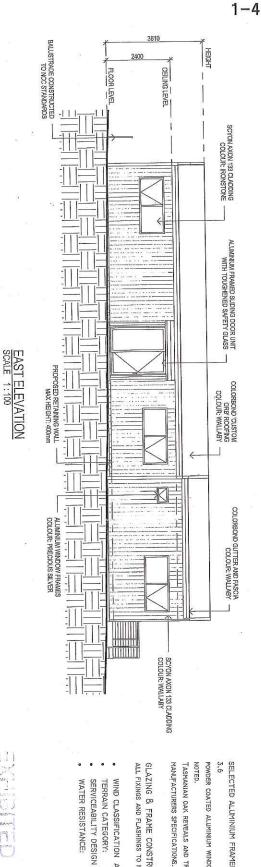
SOFFIT / EAVE LINED WITH 'HARDIFLEX' CEMENT SHEETING

TRIMMERS LOCATED WITHIN 1200 MM OF EXTERNAL CORNERS TO BE SPACED @ 500 MM CENTERS, REMAINDER OF SHEET - 700 MM CENTERS

PRODUCT MANAGEMENT SHOWE PROPERTY SHOW THE PROPERTY SHOW THE PROPERTY SHOWS THE PROPERTY

FASTENER / FIXINGS WITHIN 1200 MM OF EXTERNAL CORNERS @ 200 MM CENTERS, REMAINDER OF SHEET - 300 MM CENTERS



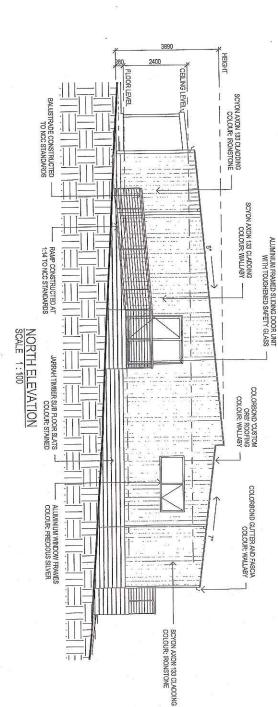

SELECTED ALUMINIUM FRAMED WINDOWS - BCA VOLUME 2 PART

POWDER COATED ALUMINIUM WINDOW & DOOR FRAMES, UNLESS OTHERWISE TASMANIAN OAK REVEALS AND TRIMS. ALL FLASHING AND FIXINGS TO

GLAZING & FRAME CONSTRUCTION TO AS 2047 & AS 1288 ALL FIXINGS AND FLASHINGS TO MANUFACTURERS REQUIREMENTS

- WIND CLASSIFICATION AS4055 WIND DESIGN:
- TERRAIN CATEGORY:
- WATER RESISTANCE:
- SERVICEABILITY DESIGN & WIND PRESSURE:

150 T2 (PARTIAL SHIELDING) N

40M/S

ISSUED FOR REVIEW

Approved: J. Pfeiffer Scale: As Shown @ A3 Drawn: O. Jones Checked: C. Parry Date Drawn: 26.05.20 Address: LOT 30 OF 84, 94, 96-102 Project: PROPOSED DWELLING Client: SAAT FAIRTLOUGH STREET, PERTH Copyright ©

Mob 0417 362 783 or 0417 545 813 ENGINEERIME tringengineeringplus.com.au PLUS (STREET LINE) Drawing No:

Bev. | Amendment

ISSUED FOR REVIEW RE-ISSUED FOR REVIEW

29.05.20 0.J 24.09.20 O.J

0 0.J Accredited Building Designer
0 0.J Designer Name: J.Pfeiffer
Thir Accreditation No: CC2211T

712020

A08

Date.

Tasbuilt Manufactured Homes & Cabins P.O Box 274, Deloraine Tasmania 7304 Ph; 03 6393 1013 admin@lasbuilthomes.com.au

tasbuilthomes

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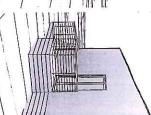
PHOJECT MANAGEMENT
CIVIL/STRUCTURAL ENGINEERING ENGINEER


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Client: SAAT Copyright ©

Address: LOT 30 OF 84, 94, 96-102 Project: PROPOSED DWELLING wob 0417 362 783 or 0417 545 813 ENGINEERIING Index of the organization of the organiz FAIRTLOUGH STREET, PERTH Drawing No:



Rev

712020

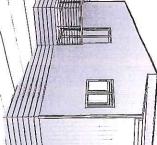A12

RE-ISSUED FOR REVIEW
ISSUED FOR REVIEW



Date Drawn: 26.05.20 Address Checket: C. Parry Approved: J. Pfeiffer Scale: As Shown @ A3 Coredited Building Designer 29.05.20 O.J. Accredited Building Designer J. Pfeiffer Accreditation No. C72211T



Bushfire Hazard Management Report: Subdivision

Report for:

6TY Pty Ltd

Property Location:

84, 94 and 96-102 Fairtlough Street, Perth

Prepared by:

Scott Livingston

Livingston Natural Resource Services

12 Powers Road Underwood, 7268

Date:

9th September 2019



1 - 423

Summary

Client:

6TY Pty Ltd obo Growth Developments Pty Ltd

84 Fairtlough Street, Perth CT 158305/101, PID 3006619

Property

identification:

94 Fairtlough Street, Perth CT 140407/1, PID 2272448

96-102 Fairtlough Street, Perth CT 140407/1, PID 7696426

Current zoning: General Residential, Northern Midlands Interim

Planning Scheme 2013

Proposal:

A 37 lot plus road subdivision is proposed from the 3 titles at at 84, 94 and

96-102 Fairtlough Street Perth.

Assessment comments:

A field inspection of the site was conducted to determine the Bushfire Risk

and Attack Level.

Assessment

by:

Scott Livingston,

Master Environmental Management,

Natural Resource Management Consultant.

Accredited Person under part 4A of the Fire Service Act 1979:

Accreditation # BFP-105.

By Lungel

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EXHIBITED

DESCRIPTION

A 37 lot subdivision is proposed from the existing 3 titles CT 158305/101, CT 140407/1 and CT 167651/ 102, Fairtlough Street, Perth. The area is mapped as Bushfire Prone. Existing dwellings on proposed Lots 10, 26 and 34 are considered exempt from the Bushfire Code for subdivision purposes.

The development is bounded to the east by Fairtlough Street and the south by Secome Street, Land to the north and east is low density residential zoned and a mosaic of low threat vegetation and grassland. Land to the south and west is developed general residential land considered low threat. The subdivision is serviced by a reticulated water supply.

See Appendix 1 for maps and site plan, and appendi2 for photographs.

BAL AND RISK ASSESSMENT

The land is mapped as within a Bushfire Prone Area on Planning Scheme Overlays.

VEGETATION AND SLOPE

	North (western section)	North (eastern section)	East	South	West
Vegetation, within 100m	0-100m	0-5m low	0-18m low	0-100m	0-100m
Subdivision boundaries	low threat	threat	threat	low threat -	low threat -
	N.	(access), 5-	(road), 18-	residential	residential
		100m	100m		9
*		grassland	grassland.		
	Flat	Flat	Flat	Down slope	Down
Slope (degrees, over 100m)	/upslope	/upslope	/upslope	0-5°	slope 0-5°
BAL Rating at boundary	Not BFP	BAL29	BAL12.5	Not BFP	Not BFP

BUILDING AREA BAL RATING

Setback distances for BAL Ratings have been calculated based on the vegetation that will exist after development and management of land within the subdivision and has also considered slope gradients.

Where no setback is required for fire protection other Planning Scheme setbacks may need to be applied, other building constraints such as topography have not been considered.



The BAL ratings applied are in accordance with the Australian Standard AS3959-2009, Construction of Buildings in Bushfire Prone Areas, and it is a requirement that any habitable building, or building within 6m of a habitable building be constructed to the BAL ratings specified in this document as a minimum.

Bushfire Attack Level (BAL)	Predicted Bushfire Attack & Exposure Level
BAL-Low	Insufficient risk to warrant specific construction requirements
BAL-12.5	Ember attack, radiant heat below 12.5kW/m²
BAL-19	Increasing ember attack and burning debris ignited by windborne embers together with increasing heat flux between 12.5-19kW/m²
BAL-29	Increasing ember attack and burning debris ignited by windborne embers together with increasing heat flux between 19-29kW/m²
BAL-40	Increasing ember attack and burning debris ignited by windborne embers together with increasing heat flux between 29-40kW/m²
BAL-FZ	Direct exposure to flames radiant heat and embers from the fire front

BUILDING SETBACKS

BAL	Slope	Grassland
BAL Low	All	50m
THE REAL PROPERTY.	Flat/ Upslope	14m
BAL 12.5	Down slope 0-5°	16m
	Flat/ Upslope	10m
BAL 19	Down slope 0-5°	11m

PROPOSED LOT BAL RATING

Proposed Lots 10, 26 and 34 have existing dwellings and are considered exempt from the Bushfire Code for subdivision purposes.

Lot	BAL	Setback
1-5	not bushfire prone	none required
6-7	BAL Low	none required
0	BAL Low	ALEC HEROTOPICS TO THE
8	BAL 12.5	8m from northern boundary
9	BAL 12.5	none required
11		
7-10	BAL Low	none required
44.40	BAL 12.5	9m from northern boundary
11-13	BAL 19	5m from northern boundary

14	BAL 12.5	none required
15-18	BAL Low	none required
19-25	BAL Low(portions not bushfire prone)	none required
27	BAL Low	none required
28	BAL Low	south east of a line between point 10m west and 18m south from the NE corner of the lot
	BAL 12.5	none required
29-33	BAL 12.5 (western facades BAL Low)	none required
35-36	BAL 12.5	none required
	BAL 12.5	9m from northern boundary
37	BAL 19	5m from northern boundary

HAZARD MANAGEMENT AREAS

Al land within the subdivision must be managed as low threat vegetation from commencement of construction on any lot under this management staging of works within the subdivision will not affect BAL rating of lots.



100 m



EXHIBITED

Subdivision roads must comply with the relevant elements of Table E1 Roads, Planning Directive No. 5.1 Bushfire-Prone Areas Code.

Table E1: Standards for roads

Element			Requirement
A.	Roads		Unless the development standards in the zone require a higher standard, the following apply:
	200		(a) two-wheel drive, all-weather construction;
			(b) load capacity of at least 20t, including for bridges and culverts;
			(c) minimum carriageway width is 7m for a through road, or 5.5m for a dead-end or cul-de-sac
	(A)		road; (d) minimum vertical clearance of 4m;
			(e) minimum horizontal clearance of 2m from the edge of the carriageway;
			(f) cross falls of less than 3 degrees (1:20 or 5%);
			(g) maximum gradient of 15 degrees (1:3.5 or 28%) for sealed roads, and 10 degrees (1:5.5 or 18%) for unsealed roads;
9			(h) curves have a minimum inner radius of 10m;
×			(i) dead-end or cul-de-sac roads are not more than 200m in length unless the carriageway is 7 metres in width;
			(j) dead-end or cul-de-sac roads have a turning circle with a minimum 12m outer radius; and
IR H		0	 (k) carriageways less than 7m wide have 'No Parking' zones on one side, indicated by a road sign that complies with Australian Standard AS1743-2001 Road signs-Specifications.

Access to lots must comply with the relevant elements of Table E2 Access, Planning Directive No. 5.1 Bushfire-Prone Areas Code.

Table E2: Standards for Property Access

A. Property access length is less than 30 metres; or access is not required for a fire appliance to access a water connection point. B. Property access length is 30 metres or greater; or access for a fire appliance to a water connection point. C. Property access length is 200 The following design and construction requirements apply to property access: than 30 metres; or access is not required for a fire appliance to a water connection point. The following design and construction requirements apply to property access: (1) All-weather construction; and construction requirements apply to property access: (2) Load capacity of at least 20 tonnes, including for bridges and culverts; (5) Minimum horizontal clearance of 4 metres; (1.30 or 5%); (3) Chross falls of less than 3 degrees (1.30 or 5%); (4) Minimum horizontal clearance of 0.5 metres from the edge of the carriageway; (5) Cross falls of less than 3 degrees (1.30 or 12.5%) entry and exit angle; (8) Curves with a minimum inner radius of 10 metres; (9) Maximum gradient of 15 degrees (1.3.5 or 28%) for unsealed roads; and (10) Terminate with a turning area for fire appliances provided by one of the following: (1) A turning circle with a minimum inner radius of 10 metres; or (b) A property access encircling the building; or (1) The following design and construction requirements apply to property access: (1) The Requirements for B above; and (1) Passing bays of 2 metres additional carriageway width and 20 metres length provided every 200		Column I	Column
Property access length is less than 30 metres; or access is not required for a fire appliance to access a water connection point. Property access length is 30 metres or greater; or access for a fire appliance to a water connection point. (1) for a fire appliance to a water (2) connection point. (4) (5) (6) (7) (8) (9) Property access length is 200 metres or greater. (1) Property access length is 200 The foll metres or greater. (1)		Element	Requirement
than 30 metres; or access is not required for a fire appliance to access a water connection point. Property access length is 30 metres or greater; or access for a fire appliance to a water connection point. (1) (2) (3) (5) (6) (6) (7) (8) (9) Property access length is 200 The foll metres or greater. (1)	P	Property access length is less	There are no specified design and construction requirements.
not required for a fire appliance to access a water connection point. Property access length is 30 metres or greater; or access for a fire appliance to a water connection point. (4) (5) (6) (7) (8) (9) Property access length is 200 metres or greater. (1) The foll (1) (1)		than 30 metres; or access is	
appliance to access a water connection point. Property access length is 30 metres or greater; or access for a fire appliance to a water connection point. (4) (5) (6) (7) (8) (9) Property access length is 200 metres or greater. (1) The following point. (1) Property access length is 200 metres or greater. (2)		not required for a fire	
connection point. Property access length is 30 metres or greater; or access for a fire appliance to a water connection point. (4) (5) (6) (7) (8) (9) Property access length is 200 metres or greater. (1)		appliance to access a water	
Property access length is 30 (1) metres or greater; or access for a fire appliance to a water connection point. (2) (5) (6) (7) (8) (9) Property access length is 200 The foll metres or greater. (1)		connection point.	
metres or greater; or access for a fire appliance to a water (2) connection point. (4) (5) (6) (7) (7) (8) (9) Property access length is 200 The followed metres or greater. (1)	.Β	Property access length is 30	The following design and construction requirements apply to property access:
for a fire appliance to a water (2) connection point. (4) (4) (5) (6) (7) (8) (9) Property access length is 200 The followed metres or greater. (1)		metres or greater; or access	(I) All-weather construction;
connection point. (3) (4) (5) (6) (6) (7) (8) (9) Property access length is 200 The followers or greater. (1)		for a fire appliance to a water	(2) Load capacity of at least 20 tonnes, including for bridges and culverts;
(4) (5) (6) (6) (7) (8) (9) Property access length is 200 The follower or greater. (1)		connection point.	(3) Minimum carriageway width of 4 metres;
(5) (6) (7) (7) (8) (9) Property access length is 200 The folometres or greater. (1)			
(6) (7) (8) (8) (9) (10 Property access length is 200 The fol metres or greater. (1)			
(7) (8) (9) (10) Property access length is 200 The follower or greater. (1)		5	
(8) (9) Property access length is 200 The followers or greater. (1)			_
(10) Property access length is 200 The followers or greater. (1)		a a	
Property access length is 200 The fol metres or greater. (1)		22	(9) Maximum gradient of 15 degrees (1:3.5 or 28%) for sealed roads, and 10 degrees (1:5.5 or 18%)
Property access length is 200 The metres or greater.			for unsealed roads; and
Property access length is 200 The metres or greater.			(10)Terminate with a turning area for fire appliances provided by one of the following:
Property access length is 200 The metres or greater.		N/ 0	(a) A turning circle with a minimum inner radius of 10 metres; or
Property access length is 200 The metres or greater.			(b) A property access encircling the building; or
Property access length is 200 The metres or greater.			(c) A hammerhead "T" or "Y" turning head 4 metres wide and 8 metres long.
metres or greater.	Ü	Property access length is 200	The following design and construction requirements apply to property access:
	10	metres or greater.	(1) The Requirements for B above; and
			(2) Passing bays of 2 metres additional carriageway width and 20 metres length provided every 200

	FIRE FIGHT				D.
	FIRE FIGHTING WATER SUPPLY	more properties.	access is provided to 3 or	greater than 30 metres, and	Property access length is
3					_

The following design and construction requirements apply to property access:

(I) Complies with Requirements for B above; and

(2) Passing bays of 2 metres additional carriageway width and 20 metres length must be provided every 100 metres.

Additional hydrants will be required to provide coverage of all lots. New hydrants must meet the requirements of Table 4, Planning Directive No. The subdivision will be serviced by a new reticulated supply. Existing hydrants on Secome Streetare within 120m of portions of the subdivision. 5.1 Bushfire-Prone Areas Code.

Table E4 Reticulated water supply for fire fighting

Element	7	Requirement
P.	Distance between	The following requirements apply:
	building area to be	(a) the building area to be protected must be located within 120m of a fire hydrant; and
	supply.	(b) the distance must be measured as a hose lay, between the fire fighting water point and the furthest
		part of the building area.
В.	Design criteria for fire	The following requirements apply:
	hydrants	(a) fire hydrant system must be designed and constructed in accordance with <i>TasWater Supplement</i> to Water Supply Code of Australia WSA 03 – 2011-3.1 MRWA 2 nd Edition; and
7.	200	(b) fire hydrants are not installed in parking areas.

Livingston Natural Resource Services

Ç Hardstand A hardstand area for fire appliances must be: (a) no more than 3m from the hydrant, measured as a hose lay; (c) a minimum width of 3m constructed to the same standard as the carriageway; and (b) no closer than 6m from the building area to be protected; (d) connected to the property access by a carriageway equivalent to the standard of the property access.

CONCLUSIONS

37 lot plus road subdivision is proposed from the existing 3 titles CT 37065/100, 18088/1, 18088/7, at Fairtlough Street Perth. The area is mapped as bushfire prone, Proposed Lot 10, 26 and 34 have existing dwellings and are considered exempt for subdivision purposes.

There is sufficient area on all lots to provide for a BAL 19 or lower for any future habitable dwellings. Construction to BAL 12.5 is also possible on all lots with increased setbacks and hazard management areas. The majority of lots are rated BAL Low or not Bushfire Prone provided all land within the subdivision is managed as low threat vegetation from commencement of construction of a habitable building on any lot within the subdivision.

Subdivision roads must comply with the relevant elements of Table E1 Roads from the *Planning Directive No. 5.1 Bushfire-Prone Areas Code.* Access to all lots must comply with the relevant elements of Table E2 Access, *Planning Directive No. 5.1 Bushfire-Prone Areas Code.* It is anticipated that no dwelling will be more than 120m as the hose lays, from a water supply point and therefore will meet element A with no specific design or construction requirements.


The subdivision will be serviced by a new reticulated supply. New hydrants will be required to service the building areas, they must meet the requirements of Table 4, *Planning Directive No. 5.1 Bushfire-Prone Areas Code*.

REFERENCES


Planning Commission (2017), Planning Directive No. 5.1 Bushfire-Prone Areas Code.

Standards Australia. (2009). AS 3959-2009 Construction of Buildings in Bushfire Prone Areas.



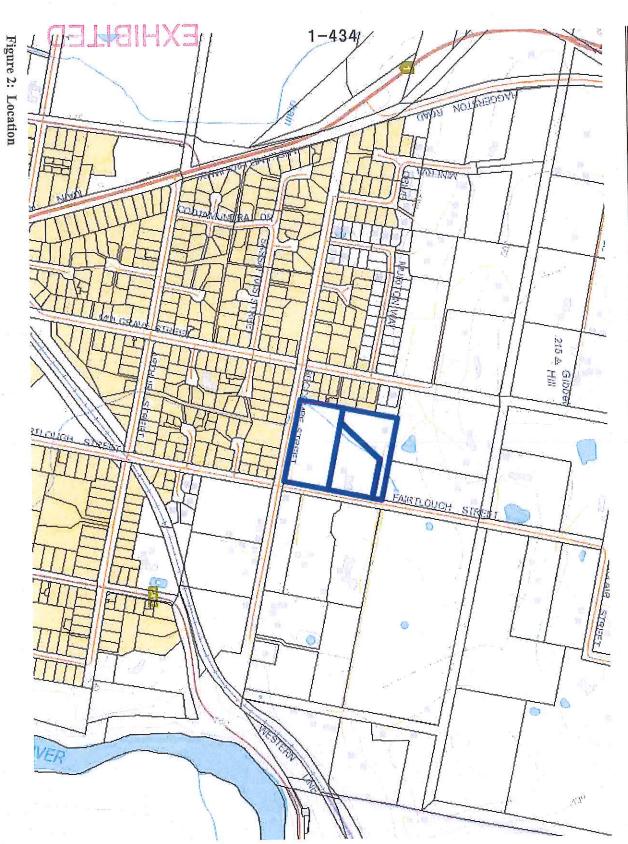

,

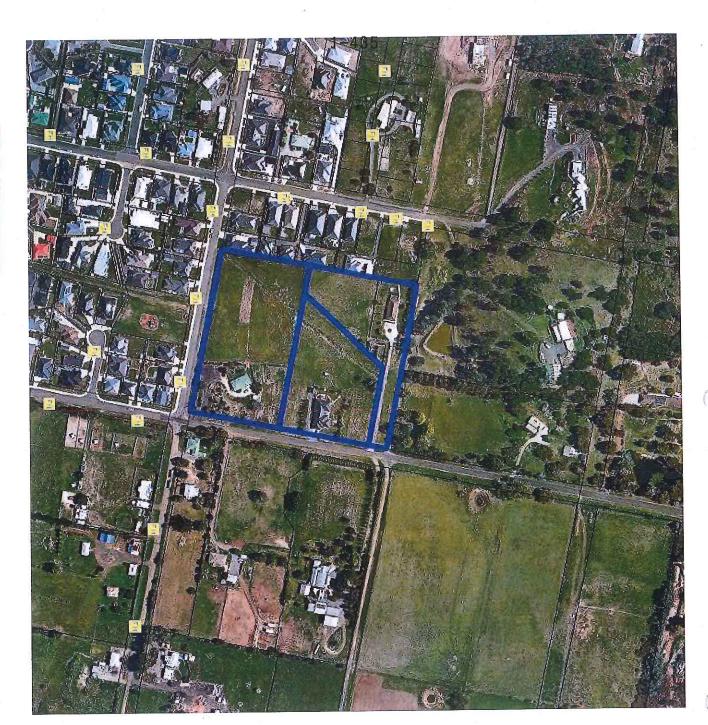

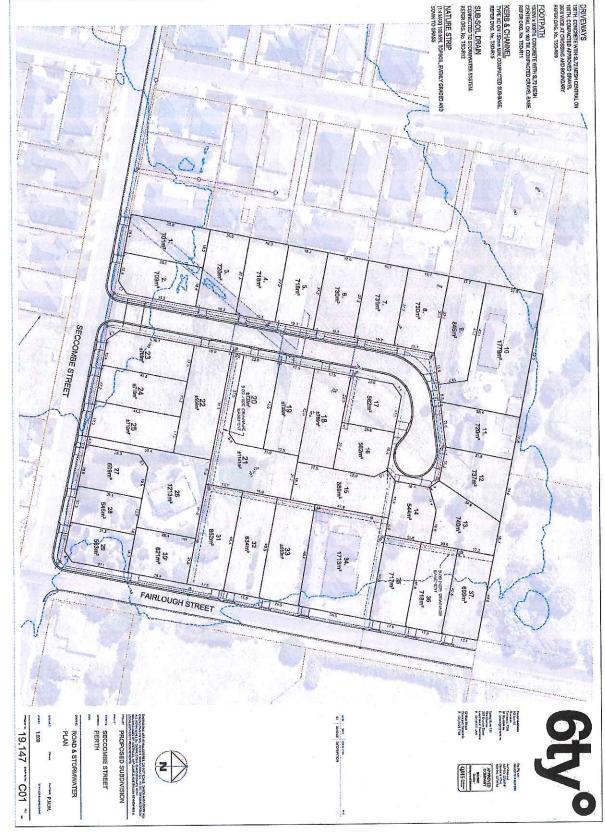




Figure 5: access to adjoining property along northern boundary



Figure 6: south west across property from Fairtlough St

EXHIBITED



Figure 7: north across property from Secome St

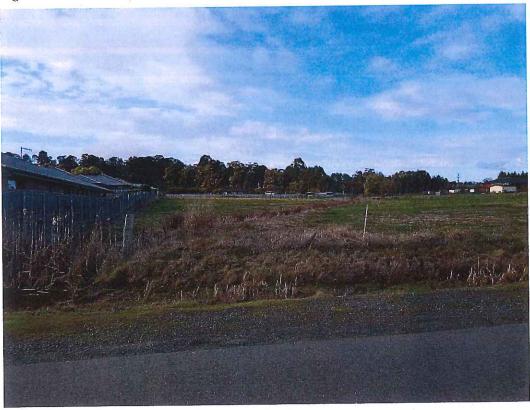


Figure 8: north along western boundary from Secome St

EXHIBITED

SRL19/50S

Page 1 of 3

N



Bushfire Hazard Management Plan: Subdivision of 84, 94, 96-102 Fairtlough St, Perth (CT 158305/101, 140407/1 & 140407/1)



Note:

Hazard Management Areas

building on any lot .: All land within the subdivision to be managed as low threat vegetation from commencement of construction of a habitable

Low Threat/ Managed Land: managed gardens or chards or lawns maintained to < 100mm in height

Maintenance Schedule:: Managed Land

- Cut lawns to less than 100mm and maintained
- Remove pine bark and other flammable garden mulch
- Prune larger trees to establish and maintain horizontal and vertical canopy separation
- Minimise storage of petroleum fuels
- Maintain road access to the dwelling and water connection point.
- Remove fallen limbs, leaf & bark from roofs, gutters and around buildings.

It should be borne in mind that the measures contained in this Bushfire Management Plan cannot guarantee that a building will survive a bushfire event on every occasion. This is substantially due to weather conditions the degree of vegetation management, the unpredictable nature and behaviour of fire and extreme

It is important to prepare your Bushfire Survival Plan, read your Community Protection Plan and know more information, visit www.fire.tas.gov.au your Nearby Safer Place. These can be obtained from your Council or the Tasmanian Fire Service. For

Construction: BAL Low, 12.5, BAL 19

Standard AS3959 Buildings in Bushfire Prone Area to be built in accordance with the Building Code of Australia and Australian

Ĺ	27	35-36	29-33		20	300		27	19-25	15-18	14	44-40	11	7-10	11	9	C	0	6-7	1-5	Lot
BAL 19	BAL 12.5	BAL 12.5	BAL 12.5 (western facades BAL Low)	BAL 12.5	BAL Low			BAL Low	BAL Low(portions not bushfire prone)	BAL Low	BAL 12.5	BAL 19	BAL 12.5	BAL Low		BAL 12.5	BAL 12.5	BALLow	BAL Low	not bushfire prone	BAL
5m from northern boundary	9m from northern boundary	none required	none required	none required	the lot	west and 18m south from the NE corner of	south east of a line between point 10m	none required	none required	none required	none required	5m from northern boundary	9m from northern boundary	none required		none required	8m from northern boundary		none required	none required	Setback

Accreditation: BFP-105: 1, 2, 3A, 3B, 3C Date 9/9/2019 Scott Livingston

SRL19/50S

Access

If access exceeds 30m, to a to a habitable building or water supply point it must be constructed to the following

The following design and construction requirements apply to property access:

All-weather construction;

Load capacity of at least 20 tonnes, including for bridges and culverts;

Minimum vertical clearance of 4 metres; Minimum carriageway width of 4 metres;

Cross falls of less than 3 degrees (1:20 or 5%);

Minimum horizontal clearance of 0.5 metres from the edge of the carriageway;

roads; and

ROADS

All future roads within the subdivision must comply with the following:

a. two-wheel drive, all-weather construction,

b. load capacity of at least 20t, including for bridges and culverts;

c, minimum carriageway width is 7m for a through road, or 5,5m for a dead-end or cul-de-sac

d. minimum vertical clearance of 4m;

e, minimum horizontal clearance of 2m from the edge of the carriageway; f. cross falls of less than 3 degrees (1:20 or 5%);

g. maximum gradient of 15 degrees (1:3.5 or 28%) for sealed roads, and 10 degrees (1:5.5 or b. curves have a minimum inner radius of 10m; 18%) for unsealed roads;

k. carriageways less than 7m wide have 'No Parking' zones on one side, indicated by a road sign j, dead-end or cul-de-sac roads have a turning circle with a minimum 12m outer radius; and that complies with Australian Standard AS1743-2001 Road signs-Specifications.

i, dead-end or cul-de-sac roads are not more than 200m in length unless the carriageway is 7

Water Supply

Additional Hydrants must comply with:

- Fire hydrant system must be designed and constructed in accordance with TasVVater Supplement to Water Supply Code of Australia WSA 03 2011-3.1 MRWA Edition 2.0; and
- b. Fire hydrants are not installed in parking areas

A hardstand area for fire appliances must be provided:

- no more than 3m from the hydrant, measured as a hose lay;
- No closer than six metres from the building area to be protected
- With a minimum width of three metres constructed to the same standard as the carriageway, and
- Connected to the property access by a carriageway equivalent to the standard of the property

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SRL19/50S

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Terminate with a turning area for fire appliances provided by one of the following:

Maximum gradient of 15 degrees (1.3.5 or 28%) for sealed roads, and 10 degrees (1.5.5 or 18%) for unsealed

Curves with a minimum inner radius of 10 metres; Dips less than 7 degrees (1:8 or 12.5%) entry and exit angle;

i) A turning circle with a minimum inner radius of 10 metres; or

ii) A property access encircling the building; or a hammerhead "T" or "Y" turning head 4 metres wide and 8 metres long,

Date 9/9/2019 Accreditation: BFP - 105: 1, 2, 3A, 3B, 3C

Scott Livingston

BUSHFIRE-PRONE AREAS CODE

CERTIFICATE¹ UNDER S51(2)(d) LAND USE PLANNING AND APPROVALS ACT 1993

1. Land to which certificate applies ²					
Land that <u>is</u> the Use or Development Site protection.	that is relied upon for bushfire hazard management or				
Name of planning scheme or instrument:	Northern Midlands Interim Planning Scheme 2013				
Street address:	84, 94, 96-102 Fairtlough Street, Perth				
Certificate of Title / PID:	CT 158305/101, PID 3006619 CT 140407/1, PID 2272448 CT 167651/1, PID 7696426				
Land that <u>is not</u> the Use or Development S management or protection.	Site that is relied upon for bushfire hazard				
Street address:					
Certificate of Title / PID:					
2. Proposed Use or Development					
Description of Use or Development:					
31 lot subdivision from 3 existing titles					
Code Clauses:					

¹ This document is the approved form of certification for this purpose, and must not be altered from its original form.

² If the certificate relates to bushfire management or protection measures that rely on land that is not in the same lot as the site for the use or development described, the details of all of the applicable land must be provided.

区 E1.4 Exempt Development			☐ E1.5.1 Vu	ılnerable Üse			
□Е	1.5.2 Hazardous U	Jse	E1.6.1 Subdivision				
	3. Documents	relied upon					
Docu	ıments Plans a	nd/or Specifications					
Title	1871	Proposed Subdivision					
Auth	or:	6TY Pty Ltd					
Date		16/4/2019		Version: 1			
Bush	ifire Hazard R	eport		× 20 1			
Title		Bushfire Hazard Management	Report, 84, 94, 96-	-102 Fairtlough St			
Auth	ior:	Scott Livingston					
Date		9/9/2019		Version: 1			
Bush	nfire Hazard M	anagement Plan					
Title	:	Bushfire Hazard Management	t Plan 84, 94, 96-10	02 Fairtlough St			
Autl	ior:	Scott Livingston					
Date	:	9/9/2019		Version: 1			
	er Documents						
Title	e:						
Autl	nor:		¥				
Date	2:	Ф - R - п	₩.	Version:			
	4. Nature of (Certificate					
	E1.4 – Use or	development exempt from	a this code				
	Assessment Criteria	Compliance Requ		Reference to Applicable Document(s)			
X	E1.4 (a)	Insufficient increa	se in risk	Lots 10, 26, 34 only			
	E1.5.1 – Vuln	erable Uses					
	Assessment Criteria	Compliance Requ	iirement	Reference to Applicable Document(s)			



	E1.5.1 P1	Residual risk is tolerable	
	E1.5.1 A2	Emergency management strategy	
	E1.5.1 A3	Bushfire hazard management plan	
	E1.5.2 – Hazardou	s Uses	D. C
	Assessment Criteria	Compliance Requirement	Reference to Applicable Document(s)
	E1.5.2 P1	Residual risk is tolerable	
	E1.5.2 A2	Emergency management strategy	
	E1.5.2 A3	Bushfire hazard management plan	
П	E1 6 Davidonmo	nt standards for subdivision	
	T1 6 1 Cubdimicion	1. Urospeion of hozord management 9	reac
		n: Provision of hazard management a	
	E1.6.1 Subdivision Assessment Criteria	Compliance Requirement	reas Reference to Applicable Document(s)
	Assessment		Reference to Applicable
0	Assessment Criteria	Compliance Requirement Hazard Management Areas are	Reference to Applicable
	Assessment Criteria E1.6.1 P1	Compliance Requirement Hazard Management Areas are sufficient to achieve tolerable risk	Reference to Applicable
	Assessment Criteria E1.6.1 P1 E1.6.1 A1 (a)	Compliance Requirement Hazard Management Areas are sufficient to achieve tolerable risk Insufficient increase in risk	Reference to Applicable Document(s) Bushfire Hazard Management Plan, 84, 94, 96-102 Fairtlough
	Assessment Criteria E1.6.1 P1 E1.6.1 A1 (a) E1.6.1 A1 (b)	Compliance Requirement Hazard Management Areas are sufficient to achieve tolerable risk Insufficient increase in risk Provides BAL 19 for all lots Consent for Part 5 Agreement	Reference to Applicable Document(s) Bushfire Hazard Management Plan, 84, 94, 96-102 Fairtlough
	Assessment Criteria E1.6.1 P1 E1.6.1 A1 (a) E1.6.1 A1 (b)	Compliance Requirement Hazard Management Areas are sufficient to achieve tolerable risk Insufficient increase in risk Provides BAL 19 for all lots	Reference to Applicable Document(s) Bushfire Hazard Management Plan, 84, 94, 96-102 Fairtlough Street
	Assessment Criteria E1.6.1 P1 E1.6.1 A1 (a) E1.6.1 A1 (b)	Compliance Requirement Hazard Management Areas are sufficient to achieve tolerable risk Insufficient increase in risk Provides BAL 19 for all lots Consent for Part 5 Agreement	Reference to Applicable Document(s) Bushfire Hazard Management Plan, 84, 94, 96-102 Fairtlough
	Assessment Criteria E1.6.1 P1 E1.6.1 A1 (a) E1.6.1 A1 (b) E1.6.1 A1 (c) E1.6.2 Subdivision Assessment Criteria	Compliance Requirement Hazard Management Areas are sufficient to achieve tolerable risk Insufficient increase in risk Provides BAL 19 for all lots Consent for Part 5 Agreement n: Public and fire fighting access	Reference to Applicable Document(s) Bushfire Hazard Management Plan, 84, 94, 96-102 Fairtlough Street Reference to Applicable

ĭ E1.6.2 A1 (b)	Access complies with Tables E1, E2 & E3	Bushfire Hazard Management Plan, 84, 94, 96-102 Fairtlough Street
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	Assessment Criteria	Compliance Requirement	Reference to Applicable Document(s)
	E1.6.3 A1 (a)	Insufficient increase in risk	
X	E1.6.3 A1 (b)	Reticulated water supply complies with Table E4	Bushfire Hazard Management Plan, 84, 94, 96-102 Fairtlough Street
	E1.6.3 A1 (c)	Water supply consistent with the objective	
	E1.6.3 A2 (a)	Insufficient increase in risk	
	E1.6.3 A2 (b)	Static water supply complies with Table E5	
	E1.6.3 A2 (c)	Static water supply is consistent with the objective	

5. Bu	shfire Hazard Practitioner ³		
Name:	Scott Livingston	Phone No:	0438 951 021
Address:	12 Powers Road	Fax No:	
	Underwood	Email	scottlivingston.lnra@gmail.com
	Tasmania 7250	Address:	
Accreditati	on No: BFP – 105	Scope:	1, 2, 3A, 3B, 3C
6. Co	ertification		
I, certify th	at in accordance with the authority given under Part 4A	of the Fire Ser	vice Act 1979 –
Prone A use or d consiste	or development described in this certificate is exempt fr reas in accordance with Clause E1.4 (a) because there is evelopment from bushfire to warrant any specific bushfi nt with the objectives for all the applicable standards id	is an insufficien ire protection m entified in Secti	it increase in risk to the eleasure in order to be fon 4 of this Certificate.
bushfire	an insufficient increase in risk from bushfire to warran. hazard management and/or bushfire protection in orde nsistent with the objective for each of the applicable stan te.	r for the use or	development described
and/or			
with the that is c	hfire Hazard Management Plan/s identified in Section 3 Chief Officer's requirements and can deliver an outcon onsistent with the objective and the relevant compliance ds identified in Section 4 of this Certificate.	ne for the use 01	r development described
Signed: certifier	A Lungs	***************************************	
Date:	9/9/2019 Certificate No: SRI 19/50S		

³ A Bushfire Hazard Practitioner is a person accredited by the Chief Officer of the Tasmania Fire Service under Part IVA of *Fire Service Act 1979*. The list of practitioners and scope of work is found at www.fire.tas.gov.au.



CERTIFICATE OF QUALIFIED PERSON – ASSESSABLE ITEM

Section 321

To:	Growth Developments Pty Ltd			Owner /Agent		55
	PO Box 230			Address		m 55
	Mowbray	48	Suburb/postcode			
Qualified perso	on details:				100	
Qualified person:	Scott Livingston					
Address:	12 Powers Rd			Phone No:	0438	951 201
	Underwood 7268			Fax No:		
Licence No:	BFP-105 Email address:	sco	ottliving	gston.lnrs@g	gmail.c	om
Qualifications and Insurance details:	Accredited Bushfire Assessor		Directo	ption from Column or of Building Contr nination)		e.
Speciality area of expertise:	Bushfire Assessment		Direct	iption from Column or of Building Conti nination)		
Details of work	As					
Address:	84, 94, 96-102 Fairtlough Street, Peri	h			Lot No:	1-9, 11-19, 21-33, 35- 37
	Perth	73	300	Certificate of	f title No:	158305/101 140407/1, 167651/1
The assessable item related to this certificate:	Bushfire Attack Level (BAL)		10 10 10 10	(description of the certified) Assessable item - a material; - a design - a form of colument - testing of a system or p - an inspectic performed	includes instruction compone lumbing s	nt, building ystem
Certificate deta	ails:					
Certificate type:	Bushfire Hazard		1	lescription from Co of the Director of E etermination)		
This certificate is i	n relation to the above assessable item building work, plumbing work					on work: 🗸

× .



or

Documents:	•	Bushfire Attack Level Assessment & Report
	12	
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a Marian A gran		
	я і	
Relevant calculations:	N/A	
References:	•	Australian Standard 3959 Planning Directive No.5.1 Building Amendment Regulations 2016 Director of Building Control, Determination (2017) Guidelines for development in bushfire prone areas of Tasmani

- 1. Assessment of the site Bushfire Attack Level (BAL) to Australian Standards 3959
- 2. Bushfire Hazard Management Plan

Assessed as -BAL 19, BAL 12.5, BAL Low, not Bushfire Prone

Proposal is compliant with DTS requirements, clauses 4.1, 4.2, 4.3 & 4.4 Directors Determination Requirements for Building in Bushfire Prone Areas (v2.1)

EXHIBITED

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Scope and/or Limitation	ns	
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Scope:	Attack Loyal for the o	vietina
This report was commissioned to identify the Bushfire	Allack Level for the e.	to
property. All comment, advice and fire suppression m compliance with Planning Directive No 5.1, Bushfire-F	Prone Areas Code issu	led by the
Tasmanian Planning Commission, the Building Code	of Australia and Austra	alian
Standards, AS 3959-2009, Construction of buildings i	n hushfire-prone areas	S
Limitations:	ii badiiiio prono aroac	•
The inspection has been undertaken and report provi-	ded on the understand	ing that:-
The report only deals with the potential bushfire ri	sk all other statutory as	ssessments
are outside the scope of this report.	udadari etadur de lamari do telar. Estable ditales abbonamento 🕊 🕠	
2. The report only identifies the size, volume and stat	us of vegetation at the	time the site
inspection was undertaken and cannot be relied upor	for any future develop	oment.
3. Impacts of future development and vegetation gr	rowth have not been co	onsidered.
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I certify the matters described in this certificate.		
Signed:	Certificate No:	Date:
Qualified person:	SRL19/50S	9/9/2019
- frangolin	=_ "	



Our ref: PLN-20-0176

17 August 2020



Laura Wycherley P.O. Box 274 DELORAINE TAS 7304

By email: lauraw@tasbuilthomes.com.au

Dear Ms Wycherley

Additional Information Required for Planning Application PLN-20-0176
Communal Residence at 96-102 Fairtlough Street, Perth (on Lot 30 approved by permit PLN-19-0184)

Thank you for your application. The following information is required to allow consideration of your application under the *Northern Midlands Interim Planning Scheme 2013*:

- A copy of the title for Lot 30.
- Plans showing:
 - Landscaping of the site.
 - Any sealed paths.
 - Percentage of the site free from buildings, paving and other impervious surfaces.
 - Waste storage in location(s) not visible from Fairtlough Street.
 - o Parking dimensions and turning circles.
- A report from an Accredited Bushfire Hazard Practitioner addressing clause E1.4 or E1.5 of the planning scheme.
- A Traffic Impact Assessment from a suitably qualified person addressing the impact of the reduced on-site parking provision on the traffic circulation, safety and efficiency of the surrounding area and whether parking is adequate to meet the needs of the residents of the proposed use having regard to the pattern of parking in the locality.

The planning scheme requires a 5m setback from Fairtlough Street. It will be difficult to recommend approval of the proposed 3.5m setback. However I could support a 4.5m setback (as it would be compatible with the setbacks that would be required for the adjoining properties) providing the street elevation is made more compatible with the residential environment by, for example, giving the windows a vertical orientation, including a bedroom window to the south of the front entrance, and including a 0.6m deep awning/roof (which may be within the 4.5m front setback) over the front entrance.

In accordance with Section 54 of the Land Use Planning and Approvals Act 1993, the statutory period for processing the application will not recommence until the requested information has been satisfactorily supplied. If you have any questions, please contact me on 6397 7301, or e-mail planning@nmc.tas.gov.au.



25th August 2020

Ben Trimmer Tasbuilt

Re: Expected traffic implications on Lot 13 and Lot 30, Perth - SAA Trust Homes

Hi Ben

I can confirm that each building on Lot 13 and Lot 13, Diamond Park Estate, Perth will be available as permanent group homes for people being supported by Devonfield Enterprise staff.

There will be 2 vehicles on each site, which will be driven by support staff for the 6 clients in each building.

So, it is just like an average home with 2 cars and, in my view, not needing a special traffic management report.

Yours Sincerely

Ralph Doedens

Supported Affordable Accommodation Trust

Erin Miles

From:

Paul Godier

Sent:

Thursday, 5 November 2020 11:58 AM

To:

Erin Miles

Subject:

FW: PLN-20-0177 - (Lot 13) & PLN-20-0176 - (Lot 30) - Request for additional

information

Follow Up Flag:

Follow up

Flag Status:

Flagged

From: Laura Wycherley < lauraw@tasbuilthomes.com.au>

Sent: Monday, 31 August 2020 10:16 AM

To: Paul Godier < paul.godier@nmc.tas.gov.au>

Cc: Ben Trimmer <bent@tasbuilthomes.com.au>; NMC Planning <planning@nmc.tas.gov.au> Subject: RE: PLN-20-0177 - (Lot 13) & PLN-20-0176 - (Lot 30) - Request for additional information

Good Morning Paul,

Please see below response from the owner, hope this helps:

Hi Laura

Apart from the 2 Devonfield vehicles per site,

there will be a max of 2 cars parked for support staff per home between 6am and 10pm.

But no staff cars overnight.

Please call if an issue. These houses should be treated like any other family home.

Please call if you have further questions.

Regards

Ralph Doedens

Phone

Kind Regards,



Laura Wycherley
COUNCIL LIAISON MANAGER
T: (03) 6393 1013
E: laurat@tasbuilthomes.com.au



REFERRAL OF DEVELOPMENT APPLICATION PLN-20-0176 TO WORKS & INFRASTRUCTURE DEPARTMENT

Property/Subdivision No: 104900.31

Date:

9 October 2020

Applicant:

Laura Wycherley

Proposal:

Residential (communal residence) (vary front and rear setbacks, reduce

parking provision)

Location:

96-102 Fairtlough Street (approved Lot 30, will be 102 Fairtlough Street),

Perth

W&I referral PLN-20-0176, 96-102 Fairtlough Street (approved Lot 30, will be 102 Fairtlough Street), Perth

Planning admin: W&I fees paid.

NO W&I comment.

Jonathan Galbraith (Engineering Officer)

Date: 15/10/20



Submission to Planning Authority Notice

Council Planning Permit No.	PLN-20-0176	5		Council notice date	9/10/2020
TasWater details		PATRICE STATE			
TasWater Reference No.	TWDA 2020/01632	2-NMC		Date of response	16/10/2020
TasWater Contact	Sam Bryant	Phone No.		0474 933 294	
Response issued	to				
Council name	NORTHERN MIDLA	NDS COUNCIL			
Contact details	Planning@nmc.tas	nmc.tas.gov.au		4 2	2 /
Development details					
Address	96-102 FAIRTLOUG	.02 FAIRTLOUGH ST, PERTH		Property ID (PID)	7696426
Description of development	New Dwelling	w Dwelling			
Schedule of draw	ings/documents				
Prepa	red by	Drawing/document No.		Revision No.	Date of Issue
Tasbuilt Homes /	Homes / Engineering Plus Site Plan 712020		Site Plan 712020		24/09/2020

Conditions

SUBMISSION TO PLANNING AUTHORITY NOTICE OF PLANNING APPLICATION REFERRAL

Pursuant to the Water and Sewerage Industry Act 2008 (TAS) Section 56P(1) TasWater imposes the following conditions on the permit for this application:

CONNECTIONS, METERING & BACKFLOW

 A suitably sized water supply with metered connections and sewerage system and connections to the development must be designed and constructed to TasWater's satisfaction and be in accordance with any other conditions in this permit.

Advice: Plans submitted for the Certificates for Certifiable Works (Building & Plumbing) must show the property water connection upgraded to a minimum DN32mm (ID25mm) to service the development for water in accordance with TasWater Water Metering Guidelines.

2. Any removal/supply and installation of water meters and/or the removal of redundant and/or installation of new and modified property service connections must be carried out by TasWater at the developer's cost.

DEVELOPMENT ASSESSMENT FEES

3. The applicant or landowner as the case may be, must pay a development assessment fee of \$351.28 to TasWater, as approved by the Economic Regulator and the fee will be indexed, until the date paid to TasWater.

The payment is required within 30 days of the issue of an invoice by TasWater.



Advice

General

For information on TasWater development standards, please visit http://www.taswater.com.au/Development/Development-Standards

For application forms please visit http://www.taswater.com.au/Development/Forms

Declaration

The drawings/documents and conditions stated above constitute TasWater's Submission to Planning Authority Notice.

Authorised by

Jason Taylor

Development Assessment Manager

TasWater	Contact Details		
Phone	13 6992	Email	development@taswater.com.au
Mail	GPO Box 1393 Hobart TAS 7001	Web	www.taswater.com.au

Rosemary Jones

From:

Sophie Grantham <

Sent:

Wednesday, 21 October 2020 7:04 AM

To:

NMC Planning

Subject:

Lot 30 diamond park

Dear general manager,

I have a few concerns regarding the new development on lot 30 diamond park estate. I am building my first home on lot 29, I will be living on my own, if there had been mention of this prior I probably wouldn't of purchased this particular block. I believe the deck area faces directly into my block and my whole entertaining area. As there are seven bedrooms and as I understand a staff member, and only two car parks, if there are multiple visitors I worry they will take up a lot of the street parking. My biggest concern is the resale value of my property, because people may choose something else over living beside a disability home.

Regards, Sophie grantham The General Manager Northern Midlands Council planning@nmc.tas.gov.au

Objection to Application PLN -20-0176

To Whom it may Concern

I wish to object to the above application on the following grounds:

A Communal residence including verandahs of approx. 30 squares on a 624 square metre block that requires Varying of front and rear setbacks and reduced parking provision is completely unsuitable to be built on that block.

Planning schemes are in place to protect neighbouring properties from completely unsuitable buildings being erected and having 3 important issues varied clearly shows an unsuitable block for the building. The streetscape is very unpleasant and not at all in keeping with a new subdivision or the existing residences. I believe it could devalue neighbouring properties.

I do not believe two parks is enough for the number of people who will be attending the house and as it is being built on a crest of a hill it is not suitable for staff and visitors to be parking on the street. Allowing an applicant to vary all of these issues is overboard and is a very dangerous precedent for other dwellings to be built that are not in keeping with the area and do not comply with your planning scheme.

I hope this building is considered on it's own merit and not it's intended use and you see sense and refuse to allow the variations.

Michelle Calder 13-15 Seccombe Street West PERTH TAS 7300

Phone

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Attention: The General Manager, Northern Midlands Council

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RE: Objection of the Proposed Communal Dwelling of Lot 30 (102 Fairtlough St Perth, TAS)

I am writing to express my objection regarding the proposed communal house on Lot 30 (to be 102 Fairtlough Street, Perth). As the owner of Lot 31, I will be building my first home on this block adjacent to lot 30. I am deeply saddened to learn that a communal dwelling has been proposed for the adjacent lot.

Firstly, I would like to express the concerns I have with the design of the proposed dwelling for lot 30. The design does not simply fit in with the designs of both the preexisting and other family homes that will undoubtably be built within this area. I am concerned that the non-uniform design of the building will devalue my property once established.

It is to my knowledge that lot 30 will be used to establish a group home for individuals requiring 24/7 disability support. I am concerned that parking will become an issue assuming that little to no off-street parking will be provided for staff given the size of the block. I initially purchased my block of land (lot31) presuming that I would eventually build a house in a quiet dead-end street without needing to worry about issues relating to parking and the constant noise of vehicles coming and going next door.

Having worked in the disability support sector myself, I do understand the need for these people to have access to modern purpose-built homes to reside in. However, under the circumstances, I believe that more thought needs to be added to the conversation of how the owner(s)/operator(s) of lot 30 plan to mitigate these issues that myself and, I am sure, other local residents have raised.

Kindest regards

Jessica Crowden

21 October 2020

The General Manager Northern Midlands Council,

I refer to the planning application reference number PLN-20-0177 and PLN-20-0176.

I would like to make a representation opposing the planned development based on the following issues:

The dwellings are 7 bedroom/ensuite units. There is insufficient parking, especially in a cul-de-sac, for potentially 7 vehicles. Whilst the current use may be for people without cars, the buildings may in future house 7 individual adults with vehicles. The current use (I believe) for people with disabilities may not have sufficient parking space for service providers and there is very limited public transport i.e. bus services. Taxis to services needed in Launceston will be costly.

The setbacks/surrounds to each building are minimal, leaving very little room for landscaping to soften the appearance of the industrial style proposed dwelling.

The industrial look and proposed use of the dwelling does not fit with the current constructions in close proximity to the area.

Being a communal residence which may at some point be sold and used for other communal style living, this will impact on the amenity and value of the surrounding properties.

Sincerely yours,

Michael and Sharon Wise.

Lot 35 Diamond Park Estate, Perth.

Rosemary Jones

From:

Lisa Granthamgrantham ensurement

Sent:

Wednesday, 21 October 2020 7:24 PM

To:

NMC Planning

Subject:

PLN-20-0176

Dear general manager.

I am writing to express my concern with the development of lot 30 diamond park estate.

My daughter is building in this subdivision and it will be her first home and she will be living on her own, I am concerned for her safety and I know that she would never have bought this particular block if she had known this would be built behind her home.

There will be visitors coming and going and I'm concerned this will also affect my ability to get parking.

Lisa grantham.

Sent from my iPhone

Rosemary Jones

From:

W Van Der Pols <.....

Sent:

Friday, 23 October 2020 1:15 PM

To:

NMC Planning

Subject:

PLN - 20 - 0176 Representation

To the General Manager of NMC,

As one of the current owners of this property, I would like to express my concerns with the above planning application.

As I have no issues with having this type of housing in our community, I feel that a 7 bed, 7 bath, 3 kitchen is over-doing it, especially when 2 are proposed for the area and both are situated on small lots.

I am extremely disappointed in the lack of thought gone into designing these.

As the developers we were fully aware of who is purchasing these 2 lots and we are supportive of integration of social housing in our sub-divisions. We did not expect this type of dwelling. The proposal this applicant has presented, could prevent us from selling to them in the future.

The design of these buildings show that they are of modular configuration and are in fact multiple dwellings joined together. ie: three modules with each containing 2 bedrooms, 2 bathrooms a kitchen, dining and living area. Then a central module with a bedroom, living, bathroom and laundry.

I can understand a residential dwelling having 7 bedrooms and 7 bathrooms, but to have 3 kitchens with full kitchen facilities??

This has been a clever design for the owners, which enabled them to avoid multiple dwellings under the planning scheme.

My main areas of concern are-

- 1. 10:3 of the NMC Planning Scheme (Amenity). This building has no appeal whatsoever and will impact and affect values of neighbouring properties. Every new sub-division is wary and frightened of what these designers have actually proposed here. Surely the designers realised this is a new area of Perth and therefore could have designed something a little more appropriate.
- 2. 10.3.2 (A3) Waste Management. Although there is no criteria for waste management with a single dwelling, I am concerned that a waste and recycling bin (picked up fortnightly) will not suffice for 8 adult persons, which then means more bins taking up road space.
- 3. 10.4.2 (A1) Setback from front boundary in the planning scheme is 4.5 metres. This proposal has a setback of 3.11 metres. The planning scheme states 4.5 metres unless an eaves, steps, awnings and porch, can extend not more into this area by only .6 of a metre. The porch extends 1.39 metres into the exclusion zone. All other residences in the street will need to comply to the 4.5 metre setback, making this one stand out.
- 4. Parking I am concerned with the allocated parking spots (2) for a "Communal" dwelling. There are 7 residents, who no doubt will have visitors. There are times there will be a minimum of 7 visitors which require parking, therefore taking up spaces in front of neighbouring properties. I am aware this can occur with functions on private residences but the possibility of constant visitors is greater with this type of dwelling.

As I mentioned previously, I am not against this type of housing and hope the owners and designers come up with something more appropriate for the area.

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Director

W Van Der Pols Building Contractor Growth Developments Pty Ltd Mobile _____ Email – 22nd October, 2020

The General Manager,
PO Bo 156,
LONGFORD TAS 7301

RE: PLN-20-0176 & PLN-20-0177

I write to you in regards to the proposed developments lodged by SAAT for "communal dwellings" to be constructed on Lot 30 Fairtlough Street and Lot 13 Zircon Place, Perth.

As purchaser of Lot 16, I have a number of concerns relating to these developments, particularly the proposed dwelling for Lot 13 as it will be in close proximity of my new home.

Among my concerns are the following:

Parking:

- The reduced amount of available off-street parking

 2 parking spaces seems grossly insufficient to allow enough parking for staff/carers and visitors of a facility that will house 6 + people.

- the fact too that this particular dwelling is to be constructed at the end of a cul-de-sac will make parking even more difficult as cu-de-sacs typically offer little in the way of on street parking to begin with.

 Safety risks will be heightened with the extra vehicles parking where they can on the road close by.

Increase in foot traffic:

- This is likely to occur as staff/carers and visitors will be forced to park back further down Zircon Place and walk to Lot 13.
- The potential extra cars parked on the roadside and extra traffic throughout Zircon Place will be of a concern and would likely pose additional safety hazards/risks.

Security of my property:

- How ill the security of my property be affected? How secure will these "communal dwellings" be?
- Will they be staffed at all times?

Design of Dwellings:

- While design/aesthetics can be highly subjective – I personally believe that the design of these dwellings will detract greatly from the streetscape and am worried they may cause a decline in property values in the immediate vicinities if they aren't maintained or if they need to be sold or have their use changed in the future.

Size of development:

 With the design of the dwelling requiring alterations to the set backs of Lot 30, I don't believe the original size of the blocks / locations are suitable for these communal housing developments, placing them too close to neighbouring residences.

I thank you for taking the time to consider my concerns on this matter and look forward to receiving your response.

Regards

Ben Ring

Phone:

Email: L

19th October 2020

General Manager Northern Midlands Council

c/- Email planning@nmc.tas.gov.au

Submission to Public Comments for Reference No's -

PLN-20-0176 96-102 Fairtlough Street Perth Approved Lot 30, will be 102 Fairtlough Street Perth

Residential (Communal residence) (vary front and rear setbacks, reduce parking provision)

PLN-20-0177 84 & 94 Fairtlough Street Perth Approved Lot 13, will be 12 Zircon Place Perth

Residential (communal residence) (reduced parking provision)

As a resident and ratepayer of Perth being 1 Collins Street since 2008, I make this representation to please be considered in public comments for the above planning applications. I have also been a past resident and ratepayer of Evandale dating back to 1991 evidencing long term commitment to the Northern Midlands Municipality.

Whilst I most certainly appreciate the sensitivity of the developments and the service being provided by the proponents, which each and every one of us could very easily require for ourselves or our family and friends, at any given time, I express concerns with two main points on each. Those are the size of the buildings compared to the lot sizes and the reduced parking provisions.

My home is accessed via Fairtlough Street and I believe the traffic would increase considerably with 2 communal buildings in the Diamond Park subdivision. Fairtlough Street is fairly narrow and with only 2 allotted parking spaces for 7 residents even if those residents do not drive, the visitor traffic would have an impact on access route to my residence. The buildings do not include any garaged or driveway areas as would be generally expected and accepted in residential subdivisions.

For the aesthetic nature of Perth residential areas, the building sizes are extremely large compared to the block/land allotments. This does not allow for proportionate landscaping as might be seen within most residential areas. Without formal research and knowledge, I would have thought open park areas and space should be appropriately considered. Whilst there is a park at the Secombe Street side opposite road entrance to Diamond Park, I don't believe with all of the neighbouring residences, this would be adequate for such condensed residential areas including two oversized communal developments.

Would the proponents perhaps have developments of a smaller scale for example 5 bedrooms which are more in keeping with a residential subdivision and would be a most valuable addition to our community?

I trust my submission will be taken and considered with the correct thoughts and intention.

Kind Regards

Kaylene Lewis

1 Collins Street Perth

Ph L... Email 20th October 2020

General Manager Northern Midlands Council

c/- Email planning@nmc.tas.gov.au

Submission to Public Comments for Reference No's -

PLN-20-0176 96-102 Fairtlough Street Perth Approved Lot 30, will be 102 Fairtlough Street Perth

Residential (Communal residence) (vary front and rear setbacks, reduce parking provision)

PLN-20-0177 84 & 94 Fairtlough Street Perth Approved Lot 13, will be 12 Zircon Place Perth

Residential (communal residence) (reduced parking provision)

As the purchaser of Lot 3 Diamond Park Estate Perth I submit this representation to public comments for the above planning applications.

The proposed development at the end of cul-de-sac directly past my property, has only 2 allotted parking spaces for 7 bedrooms/residents. The resident and visitor traffic has the potential to create congestion within the street and cul-de-sac area, even if residents are supported and do not drive or own vehicles. The buildings do not include any garaged or driveway areas to ease congestion as is normally the case in a residential subdivision.

The same applies for the proposed development on Fairtlough Street which will also add traffic to the area with reduced parking allotted.

Both building sizes are too large for their blocks and the area. This does not allow yard space for day use therefore overflowing to the street areas.

The developments have an industrial look and are very large for the lots, which is not in keeping with a residential subdivision. An alternative option could be a 4 bedroom house with yard for activities. That would also allow space within the lot for driveway, garage and additional adequate parking.

additional adequate parking.	
Hopefully my concerns are viewed with open mindedness.	

Jared Lewis Purchaser – Lot 3 Diamond Park Estate, Perth

Ph ...____ Email j " ______

Rosemary Jones

From:

Hannah Marshall < ______

Sent:

Thursday, 22 October 2020 8:41 PM

To:

NMC Planning

Subject:

ATTN General Manager - RE development on Lot 30 Diamond Park Estate PERTH

Hi,

I am writing with concerns about the current plan of development on Lot 30 Diamond Park Estate, Perth.

I live close to this area and was not aware there was plans for communal housing.

I walk my dog frequently past this area of a morning and night. I am concern for my safety and others.

Diamond park estate, is a narrow street and with so many houses already crammed into a small area plus existing houses on seccombe street, parking is already very limited. I feel this development would only add to the problem.

Thank you for taking the time to read my email.

Kind regards Hannah Marshall 5 Muirton Way, Perth, TAS 7300 The General Manager

PO Box 156

NORTHERN MIDLANDS COUNCIL File No.

FEO'D 2 2 OCT 2020

Property Attachments

LONGFORD TAS 7301
Date: 22/10/20
I, STEPHEN FRANKLOWBE wish to make a representation to planning application number: -N-20-0176 on the following grounds:
1. UNSUHTLY CONSTRUCTION (BUILDING) FOR NEW SUBBIVISION
2. BEING COMMUNAL RESIDENCE OF 7 BEDROOM, INSUFFICENT
OFF STREET PARKING ON PROPERTY 3. OVERFLOW PARKING ONTO FAIRTLOUGH ST WILL CAUSE
TRAFFIC ISSUES WITH EXCESSIVE CAR VARILING ON STREET VESTRICTING TRAFFIC FLOW AND BEING BANGERDUS FOR
Yours sincerely PEDESTRIAN'S ESPECIALLY GIVEN THE BLIND RISE IN THE STREET LIMITING VIEWING TO A SHORT
DISTANCE
A taheonle
Email: Strankcombe @ haywards - steel com
Address: 6 COCLINS STREET PERTH Contact Number: 4 4